



J.L. Richards & Associates Limited 700 - 1565 CARLING AVENUE Ottawa, ON Canada K1Z 8R1 Tel: 613 728 3571



GEORGIAN ROAD




PRINCE EDWARD ROAD




NORMAN ROAD

ICIP SIDEWALK PROGRAM GEORGIAN, PRINCE EDWARD & NORMAN ROAD

Sheet Number	Sheet Title			
CS	Cover Sheet			
C01	Georgian General Plan			
C02	Georgian Plan and Profile			
C03	Georgian Plan and Profile			
C04	Georgian Typical Cross Sections_Phase 2			
C05	Georgian Road Details			
C06	Prince Edward General Plan			
C07	Prince Edward Plan and Profile			
C08	Prince Edward Plan and Profile			
C09	Prince Edward Plan and Profile			
C10	Prince Edward Plan and Profile			
C11	Prince Edward Plan and Profile			
C12	Prince Edward Plan and Profile			
C13	Prince Edward Typical Cross Sections			
C14	Prince Edward Details			
C15	Norman General Plan			
C16	Norman Plan and Profile			
C17	Norman Plan and Profile			
C18	Norman Typical Cross Sections			
C19	Norman Details			

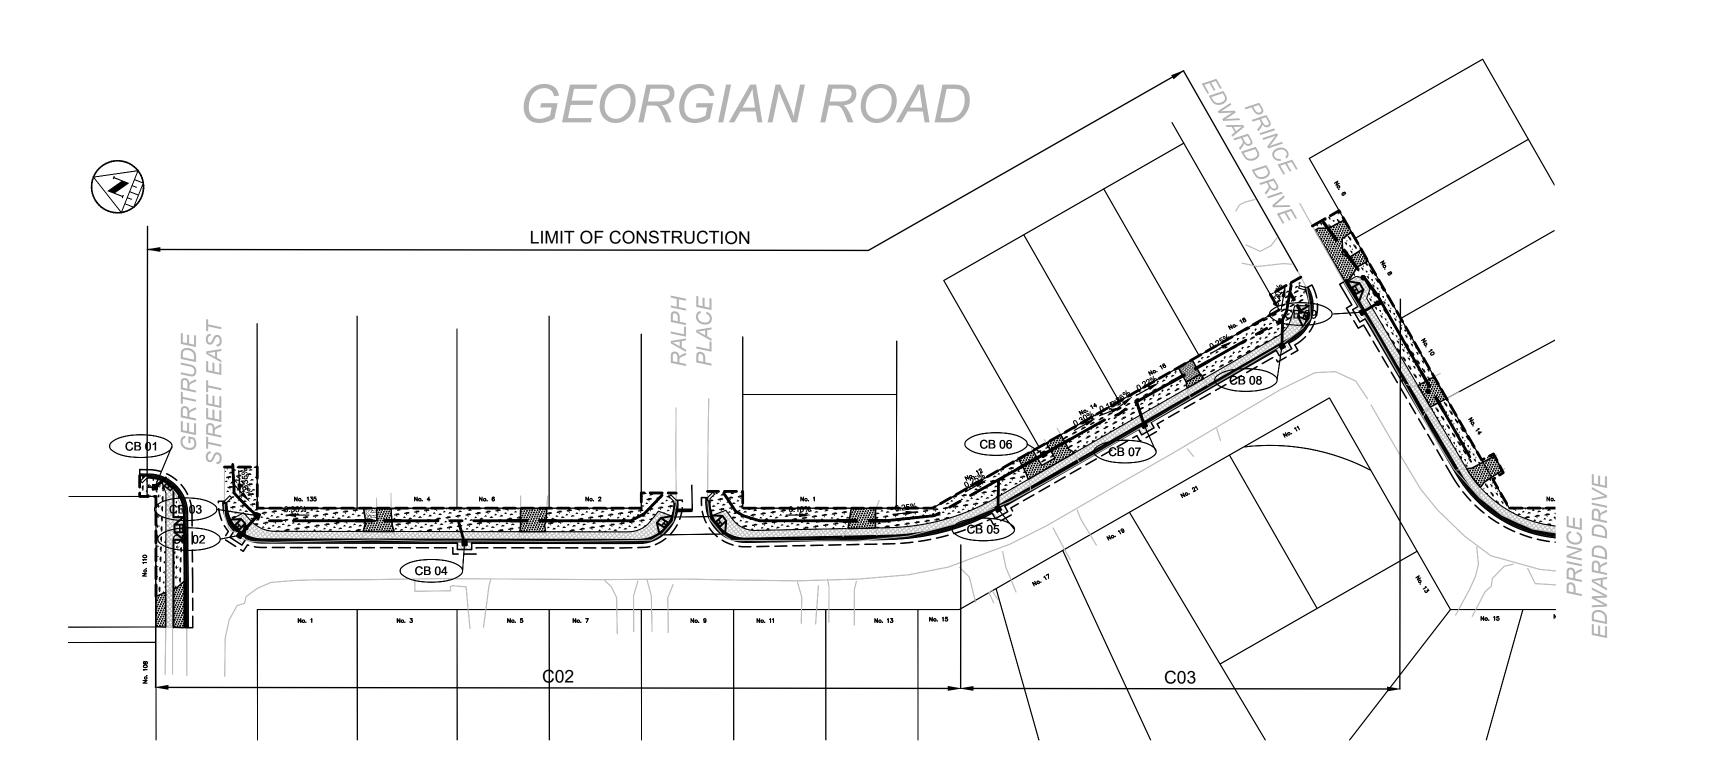

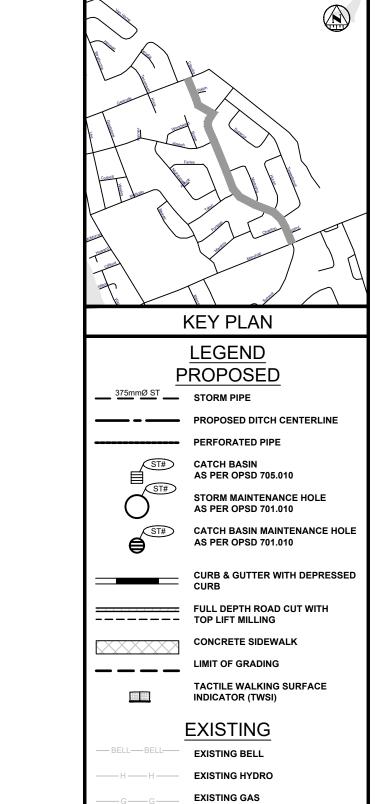

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	LOT/CONCESSION LINES
MH##	EX. MAINTENANCE HOLE
	EDGE OF PAVEMENT
$\bowtie\otimes$	HYDRO POLE/LIGHT
	EXISTING DITCH
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EXISTING SANITARY PIPE

REVISIONS					
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2	DEC 23 2021	CL	ISSUED FOR 60% DESIGN		
3	APR 29 2022	CL	ISSUED FOR 90% DESIGN		
4	DEC 09 2022	CL	ISSUED FOR CLIENT REVIEW		
5	DEC 16 2022	CL	ISSUED FOR TENDER		
	JAN		DE ICCUED FOR TENDER		







CITY OF NORTH BAY
ICIP SIDEWALK
PROGRAM

NEW CONSTRUCTION

Georgian Road General Plan

Drawing Set:

01 of 19

Designer: A.Y. / C.B.	Checked by: D.L.
Date: 12/01/2021	Approved by: C.L.

Scale: 1:750 - GEORGIAN ROAD

Drawing Number:

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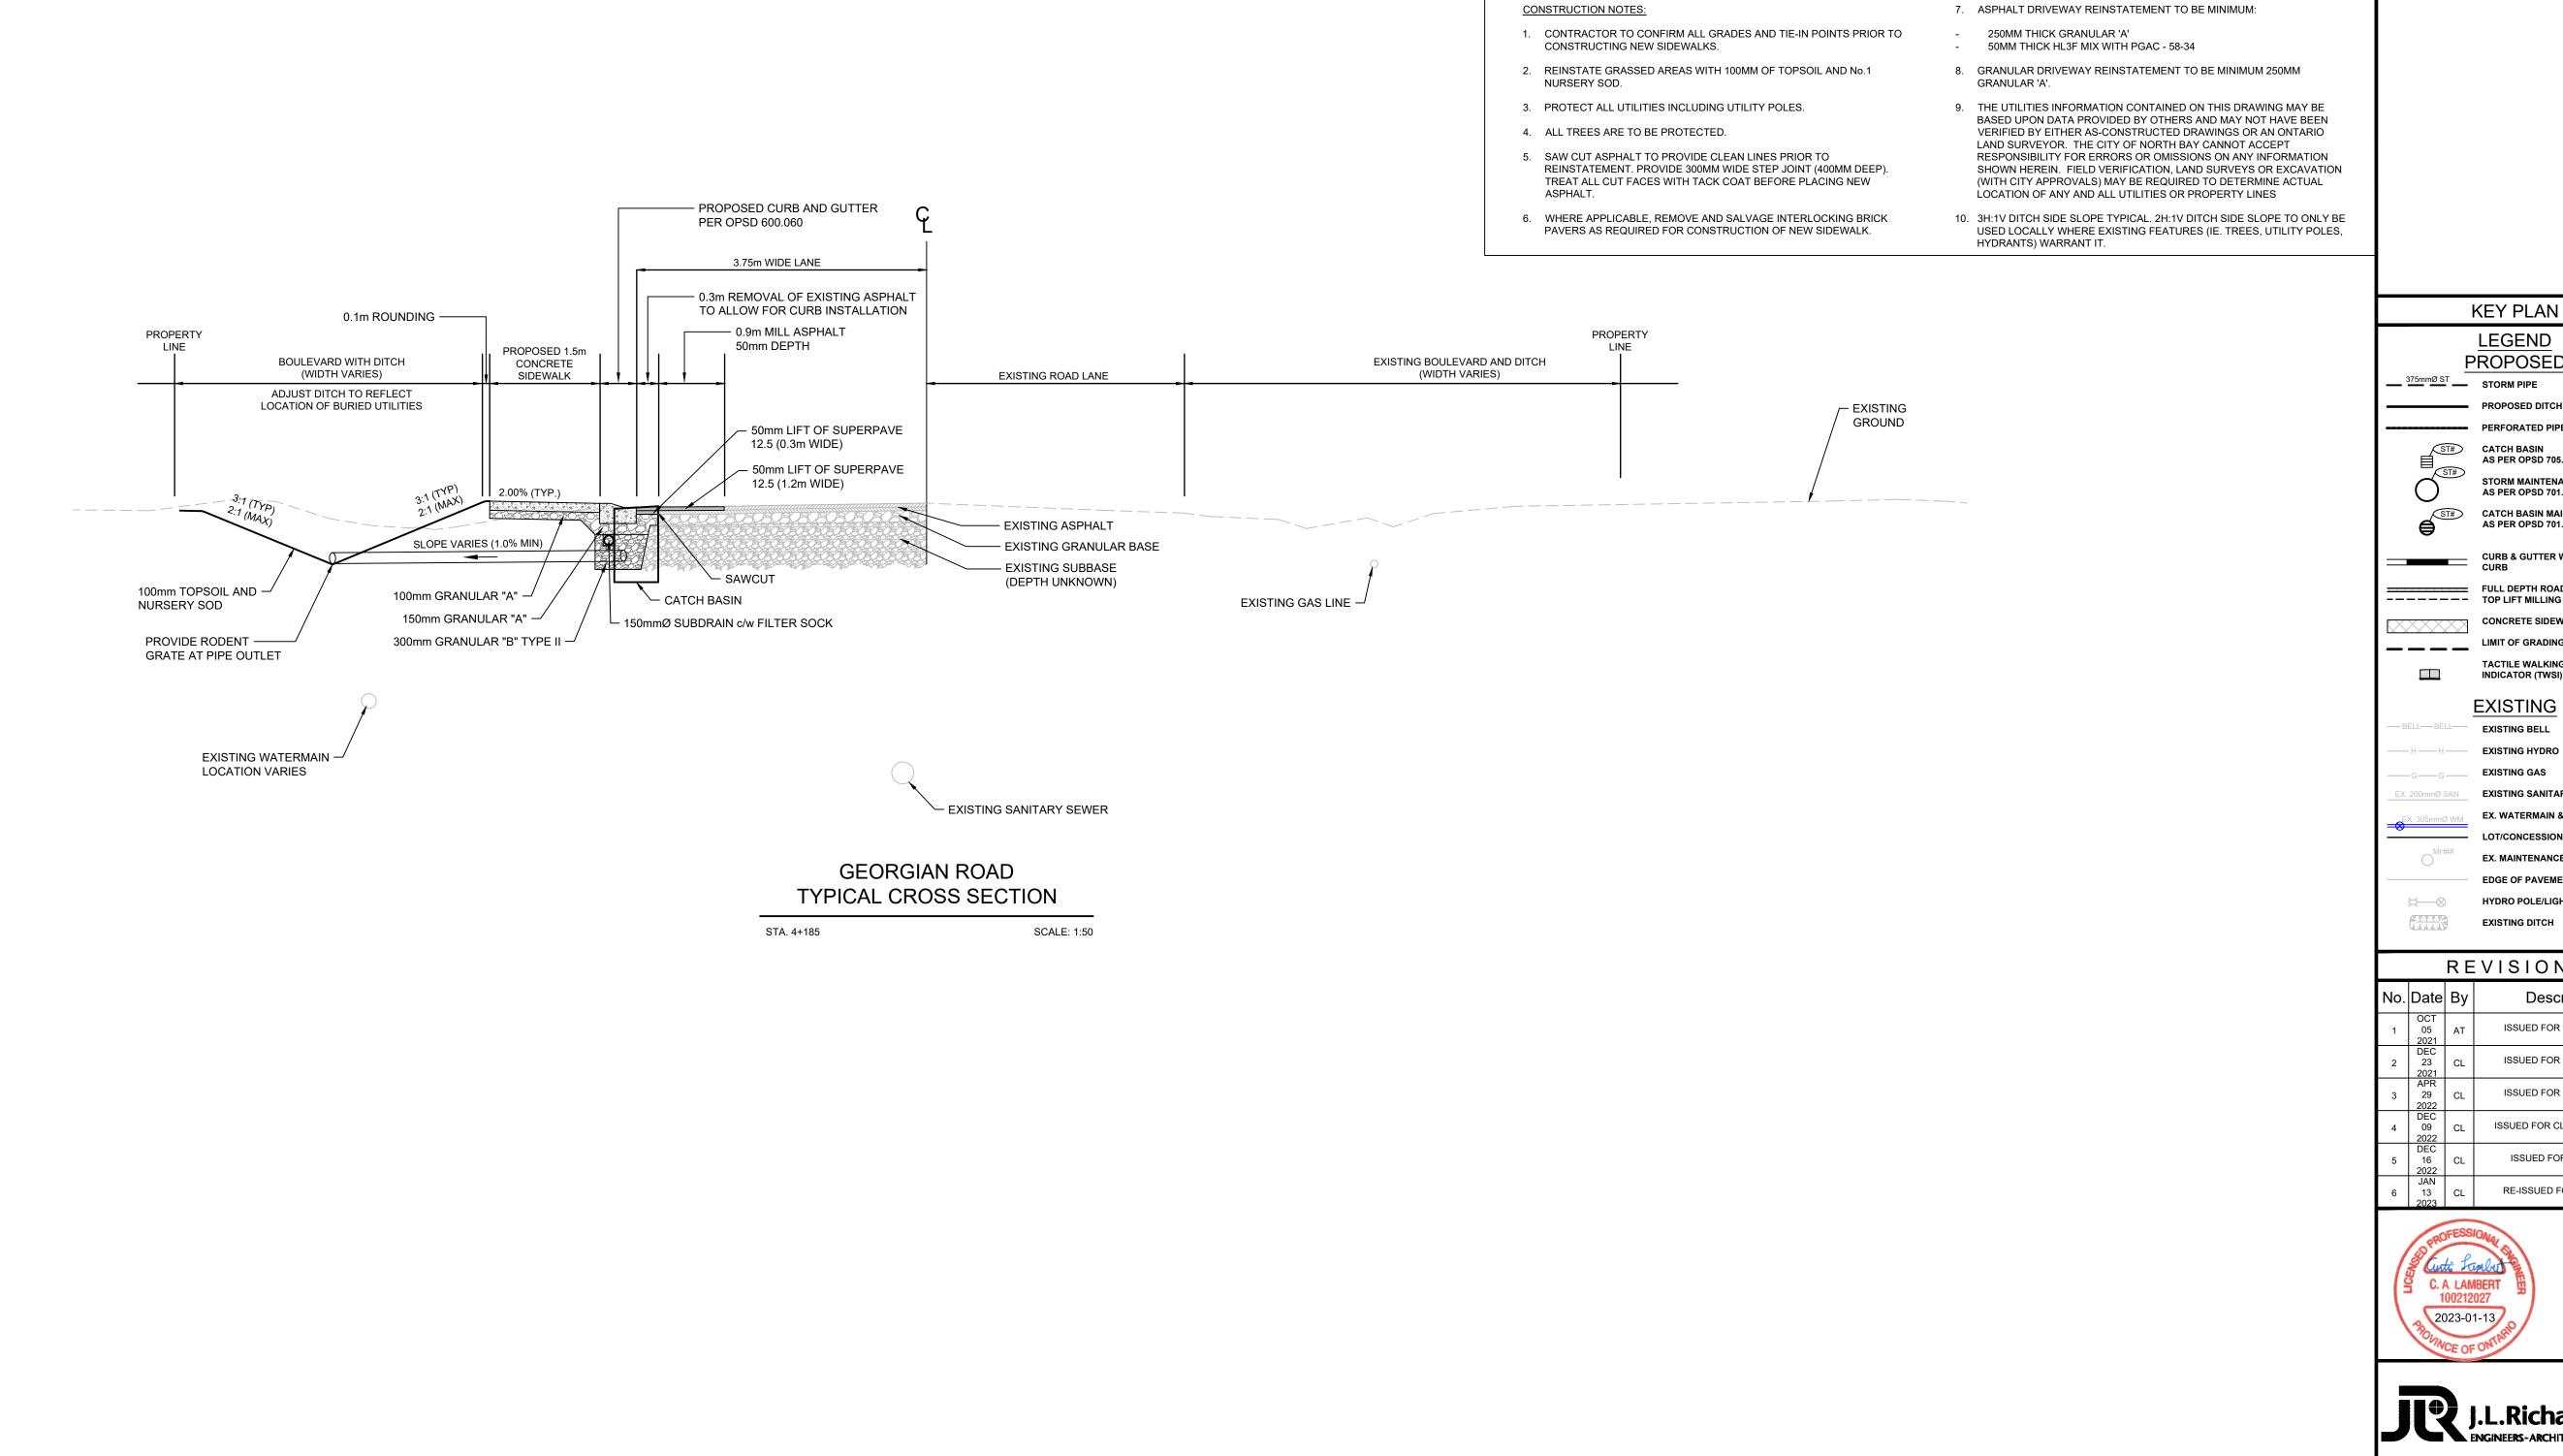
CONSTRUCTION NOTES:

- THE LOCATION OF THE UTILITIES IS APPROXIMATE ONLY. THE EXACT LOCATION SHOULD BE DETERMINED BY CONSULTING THE MUNICIPAL AUTHORITIES AND UTILITY COMPANIES CONCERNED. THE CONTRACTOR SHALL PROVE THE LOCATION OF UTILITIES AND SHALL BE RESPONSIBLE FOR ADEQUATE PROTECTION FROM DAMAGE.
- 2. ALL DIMENSIONS ARE IN METERS UNLESS OTHERWISE NOTED.
- 3. WITH THE EXCEPTION OF THE CITY OF NORTH BAY CONSTRUCTION SPECIFICATIONS & STANDARD DETAIL DRAWINGS REFERRED TO IN THIS CONTRACT, ONTARIO PROVINCIAL STANDARD DRAWINGS (OPSD) & STANDARD SPECIFICATIONS (OPSS) SHALL APPLY TO THIS CONTRACT.
- 4. ALL BASE MAPPING IS REFERENCED TO NORTH AMERICAN DATUM OF 1983 (NAD83)
- 5. ALL DISTURBED AREAS (SIDEWALK, PAVEMENT, CURB, SOD, ETC.) TO BE REINSTATED TO EXISTING CONDITIONS OR BETTER PER CITY OF NORTH BAY STANDARDS.
- 6. REFER TO GEOTECHNICAL REPORT. SOIL INFORMATION SHOWN IS NOT GUARANTEED AND CONTRACTORS ARE ADVISED TO COLLECT ADDITIONAL SOILS INFORMATION AS DEEMED NECESSARY.
- CONTRACTOR TO ADVISE CONTRACT ADMINISTRATOR IMMEDIATELY OF ANY KNOWN CONFLICTS WITH TREES AND/OR EXISTING UTILITIES.
- THE CONTRACTOR SHALL REMOVE, SALVAGE AND STORE IN SAFE AREA ALL EXISTING SIGNAGE IMPACTED BY WORK. REINSTATE ALL SIGNAGE AS PART OF WORK.

- THE CONTRACTOR IS RESPONSIBLE FOR PROVIDING PROTECTION FOR ALL EXISTING UNDERGROUND AND ABOVE GROUND UTILITIES DURING CONSTRUCTION.
- 10. THE REINSTATEMENT DRAWINGS ARE APPROXIMATE ONLY AND ARE BASED ON SURVEY AND BASE MAPPING INFORMATION, WHICH MAY NOT INCLUDE ALL LANDSCAPING FEATURES AND DETAILS. SOME LANDSCAPING FEATURES MAY ALSO HAVE BEEN CHANGED BY HOMEOWNERS SINCE THE SURVEY WAS COMPLETED. THE CONTRACTOR SHALL BE SOLELY RESPONSIBLE FOR THE DOCUMENTS/PHOTOGRAPHING THE PRE-CONSTRUCTION CONDITIONS AND LANDSCAPING AT EACH PROPERTY PRIOR TO CARRYING OUT ANY REMOVALS. REINSTATEMENT SHALL MATCH THE PRE-CONSTRUCTION CONDITIONS UNLESS DIRECTED OTHERWISE BY THE CONTRACT
- 11. EXISTING UNDERGROUND UTILITIES AND SERVICES DEPICTED ON THE DRAWINGS REPRESENT LOCATIONS IDENTIFIED ON THE CITY'S RECORD DRAWINGS. NOT ALL EXISTING UNDERGROUND UTILITIES AND SERVICES ARE DEPICTED ON THESE DRAWINGS. NO REPRESENTATION AS TO THE DEPTH OF ALL UTILITIES AND SERVICES IS MADE.
- 12. CONTRACTOR TO MAINTAIN ACCESS AT ALL TIMES TO ALL MH'S, VALVE BOXES AND VALVE CHAMBERS.

ADMINISTRATOR.

- 13. CONTRACTOR SHALL EXCAVATE NEAR AND TEMPORARILY SUPPORT EXISTING UTILITIES IN ACCORDANCE WITH THEIR THIRD-PARTY REQUIREMENTS. THE USE OF HYDRO-EXCAVATION IN THE VICINITY OF EXCAVATION AND TREES IS INCLUSIVE TO THE EXCAVATION WORK.
- 14. CONTRACTOR TO CONFIRM ALL PROPOSED STORM AND DITCH OUTLET ELEVATIONS AT THE ONSET OF CONSTRUCTION. NOTIFY THE CA OF ANY DISCREPANCIES.



KEY PLAN LEGEND PROPOSED ____ 375mmØ ST ____ STORM PIPE PROPOSED DITCH CENTERLINE PERFORATED PIPE ST# CATCH BASIN AS PER OPSD 705.010 STORM MAINTENANCE HOLE AS PER OPSD 701.010 ST# CATCH BASIN MAINTENANCE HOLE AS PER OPSD 701.010 CURB & GUTTER WITH DEPRESSED CURB FULL DEPTH ROAD CUT WITH CONCRETE SIDEWALK TACTILE WALKING SURFACE INDICATOR (TWSI) **EXISTING** EXISTING BELL **EXISTING HYDRO EXISTING GAS** EX. 200mmØ SAN EXISTING SANITARY PIPE EX. WATERMAIN & VALVE LOT/CONCESSION LINES EX. MAINTENANCE HOLE **EDGE OF PAVEMENT**

REVISIONS

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5	DEC 16 2022	CL	ISSUED FOR TENDER
6	JAN 13	CL	RE-ISSUED FOR TENDER







CITY OF NORTH BAY ICIP SIDEWALK PROGRAM


NEW CONSTRUCTION

GEORGIAN ROAD TYPICAL CROSS SECTIONS

Designer: A.Y. / C.B.	Checked by: D.L.	
Date: 12/01/2021	Approved by: C.L.	
Scale:		40

1:250 2.5 0 1:50 0.5 0 Drawing Number:

Drawing Set: **04 of 19**

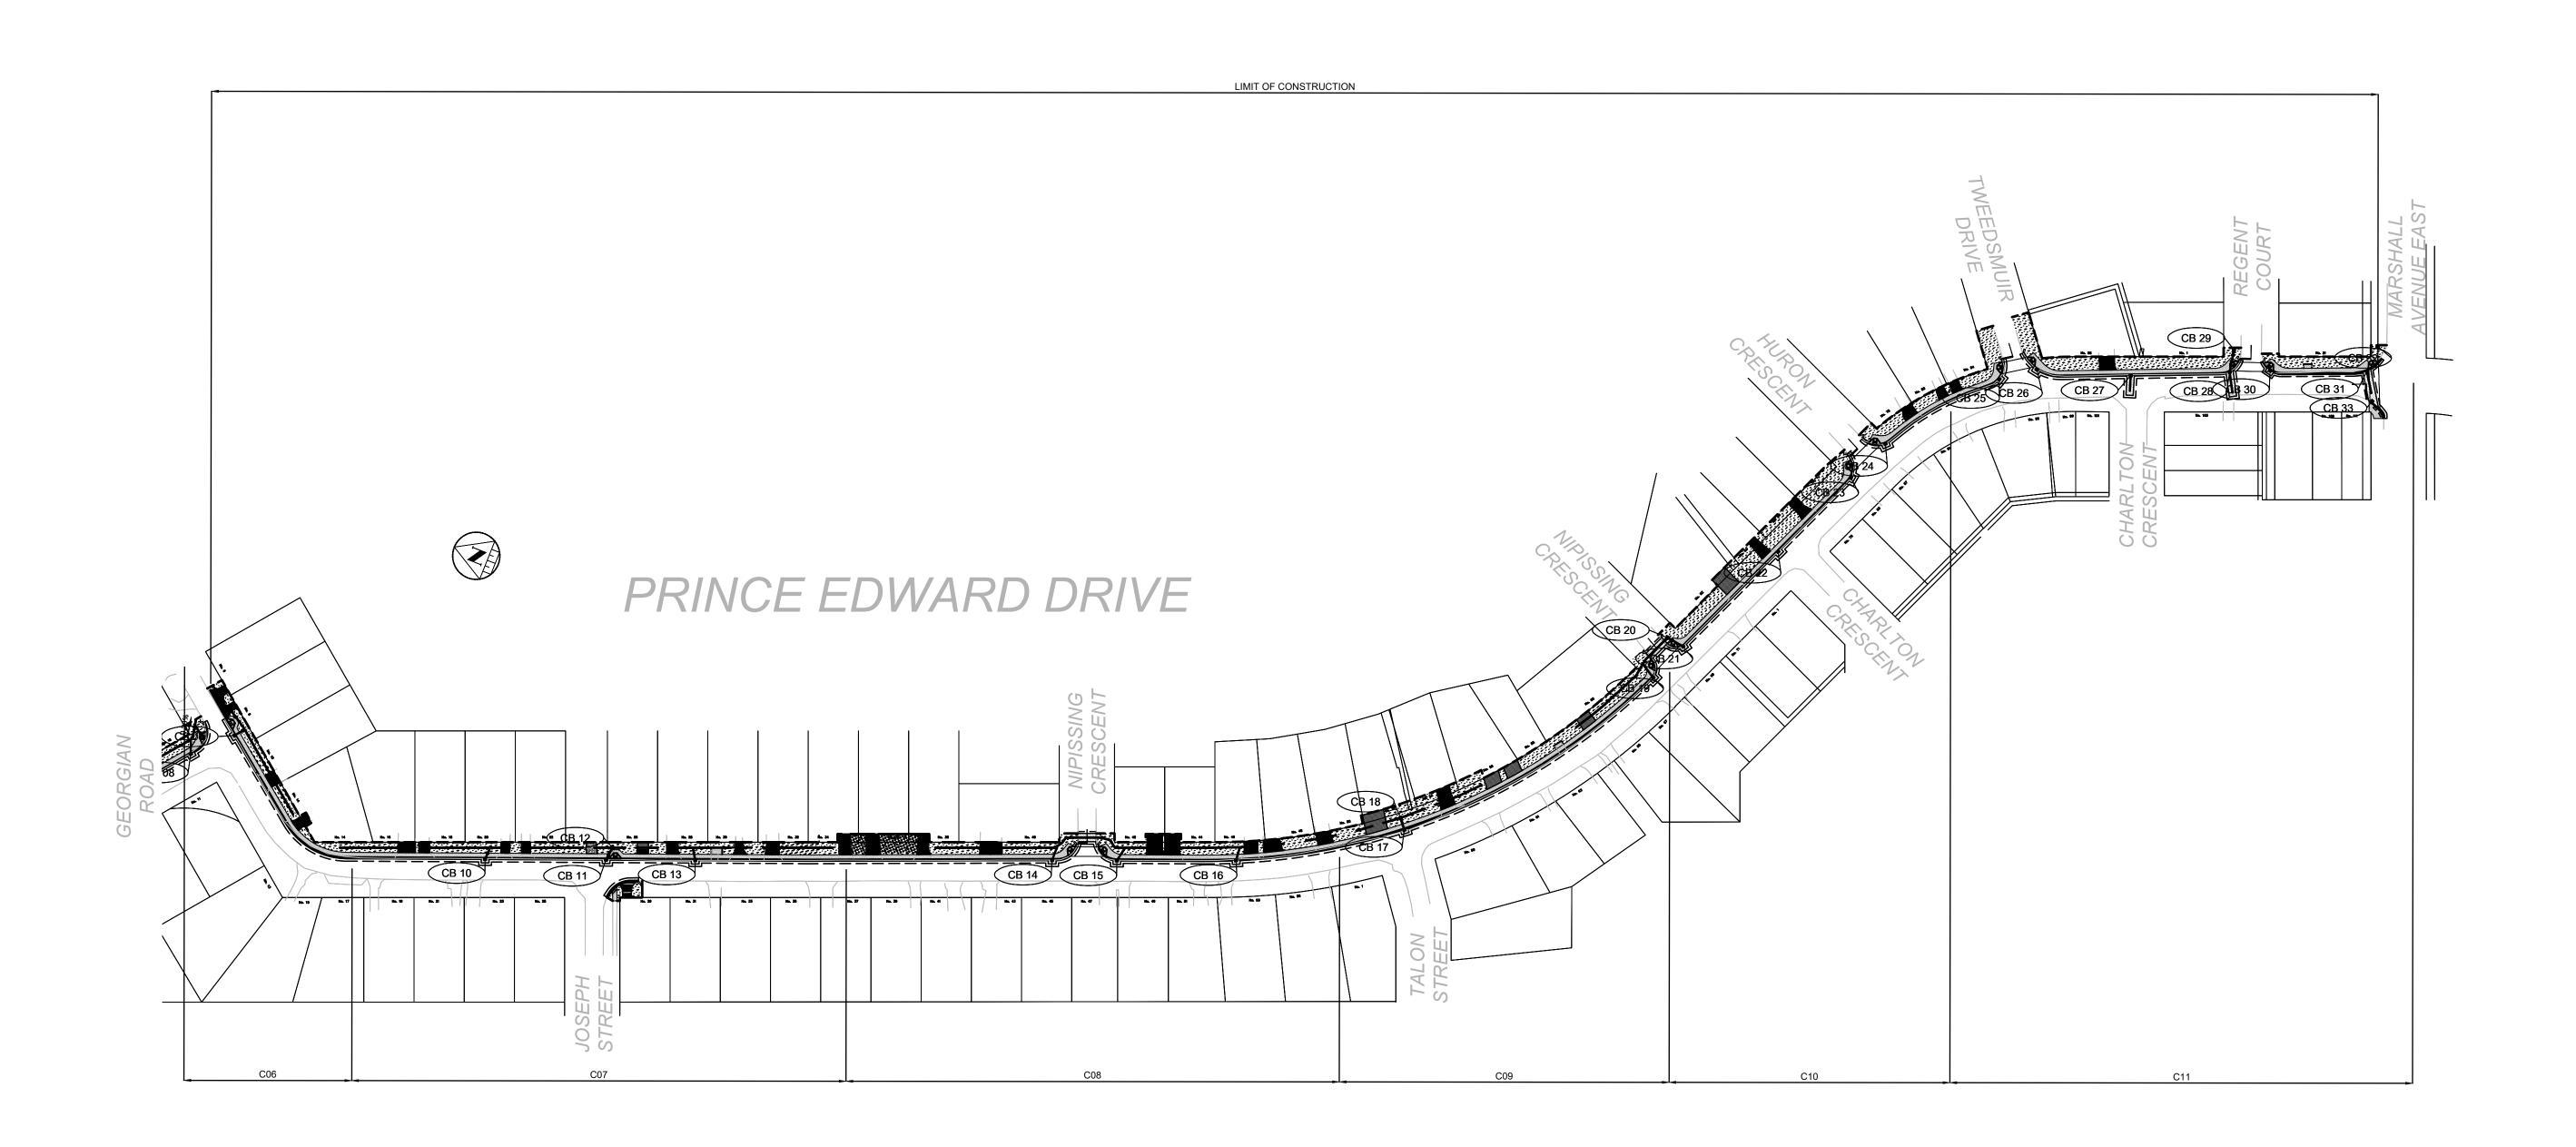

CONSTRUCTION NOTES:


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CONSTRUCTION.

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KEY PLAN

LEGEND
PROPOSED

STORM PIPE
PROPOSED DITCH CENTER
PERFORATED PIPE

CATCH BASIN
AS PER OPSD 705.010

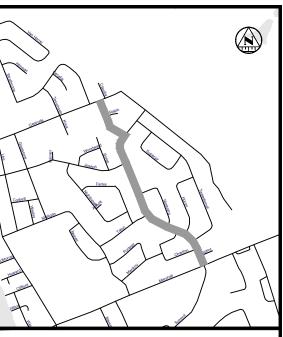STORM MAINTENANCE HOLE
AS PER OPSD 701.010

CATCH BASIN MAINTENANCE

CURB & GUTTER WITH DEPRES
CURB

FULL DEPTH ROAD CUT WITH
TOP LIFT MILLING

LIMIT OF GRADING

TACTILE WALKING SURFACE INDICATOR (TWSI)

EXISTING
EXISTING BELL

H H EXISTING HYDRO

EXISTING GAS

EX. 305mmØ SAN

EXISTING SANITARY PIPE

EX. WATERMAIN & VALVE

LOT/CONCESSION LINES

EX. MAINTENANCE HOLE

EDGE OF PAVEMENT
HYDRO POLE/LIGHT
EXISTING DITCH

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CITY OF NORTH BAY
ICIP SIDEWALK
PROGRAM

NEW CONSTRUCTION

Prince Edward Drive General Plan

Designer: Checked by:
A.Y. / C.B. D.L.

Date: Approved by:
12/01/2021 C.L.


1:1250 - PRINCE EDWARD DRIVE

Drawing Number:

C06

Drawing Set:

06 of 19

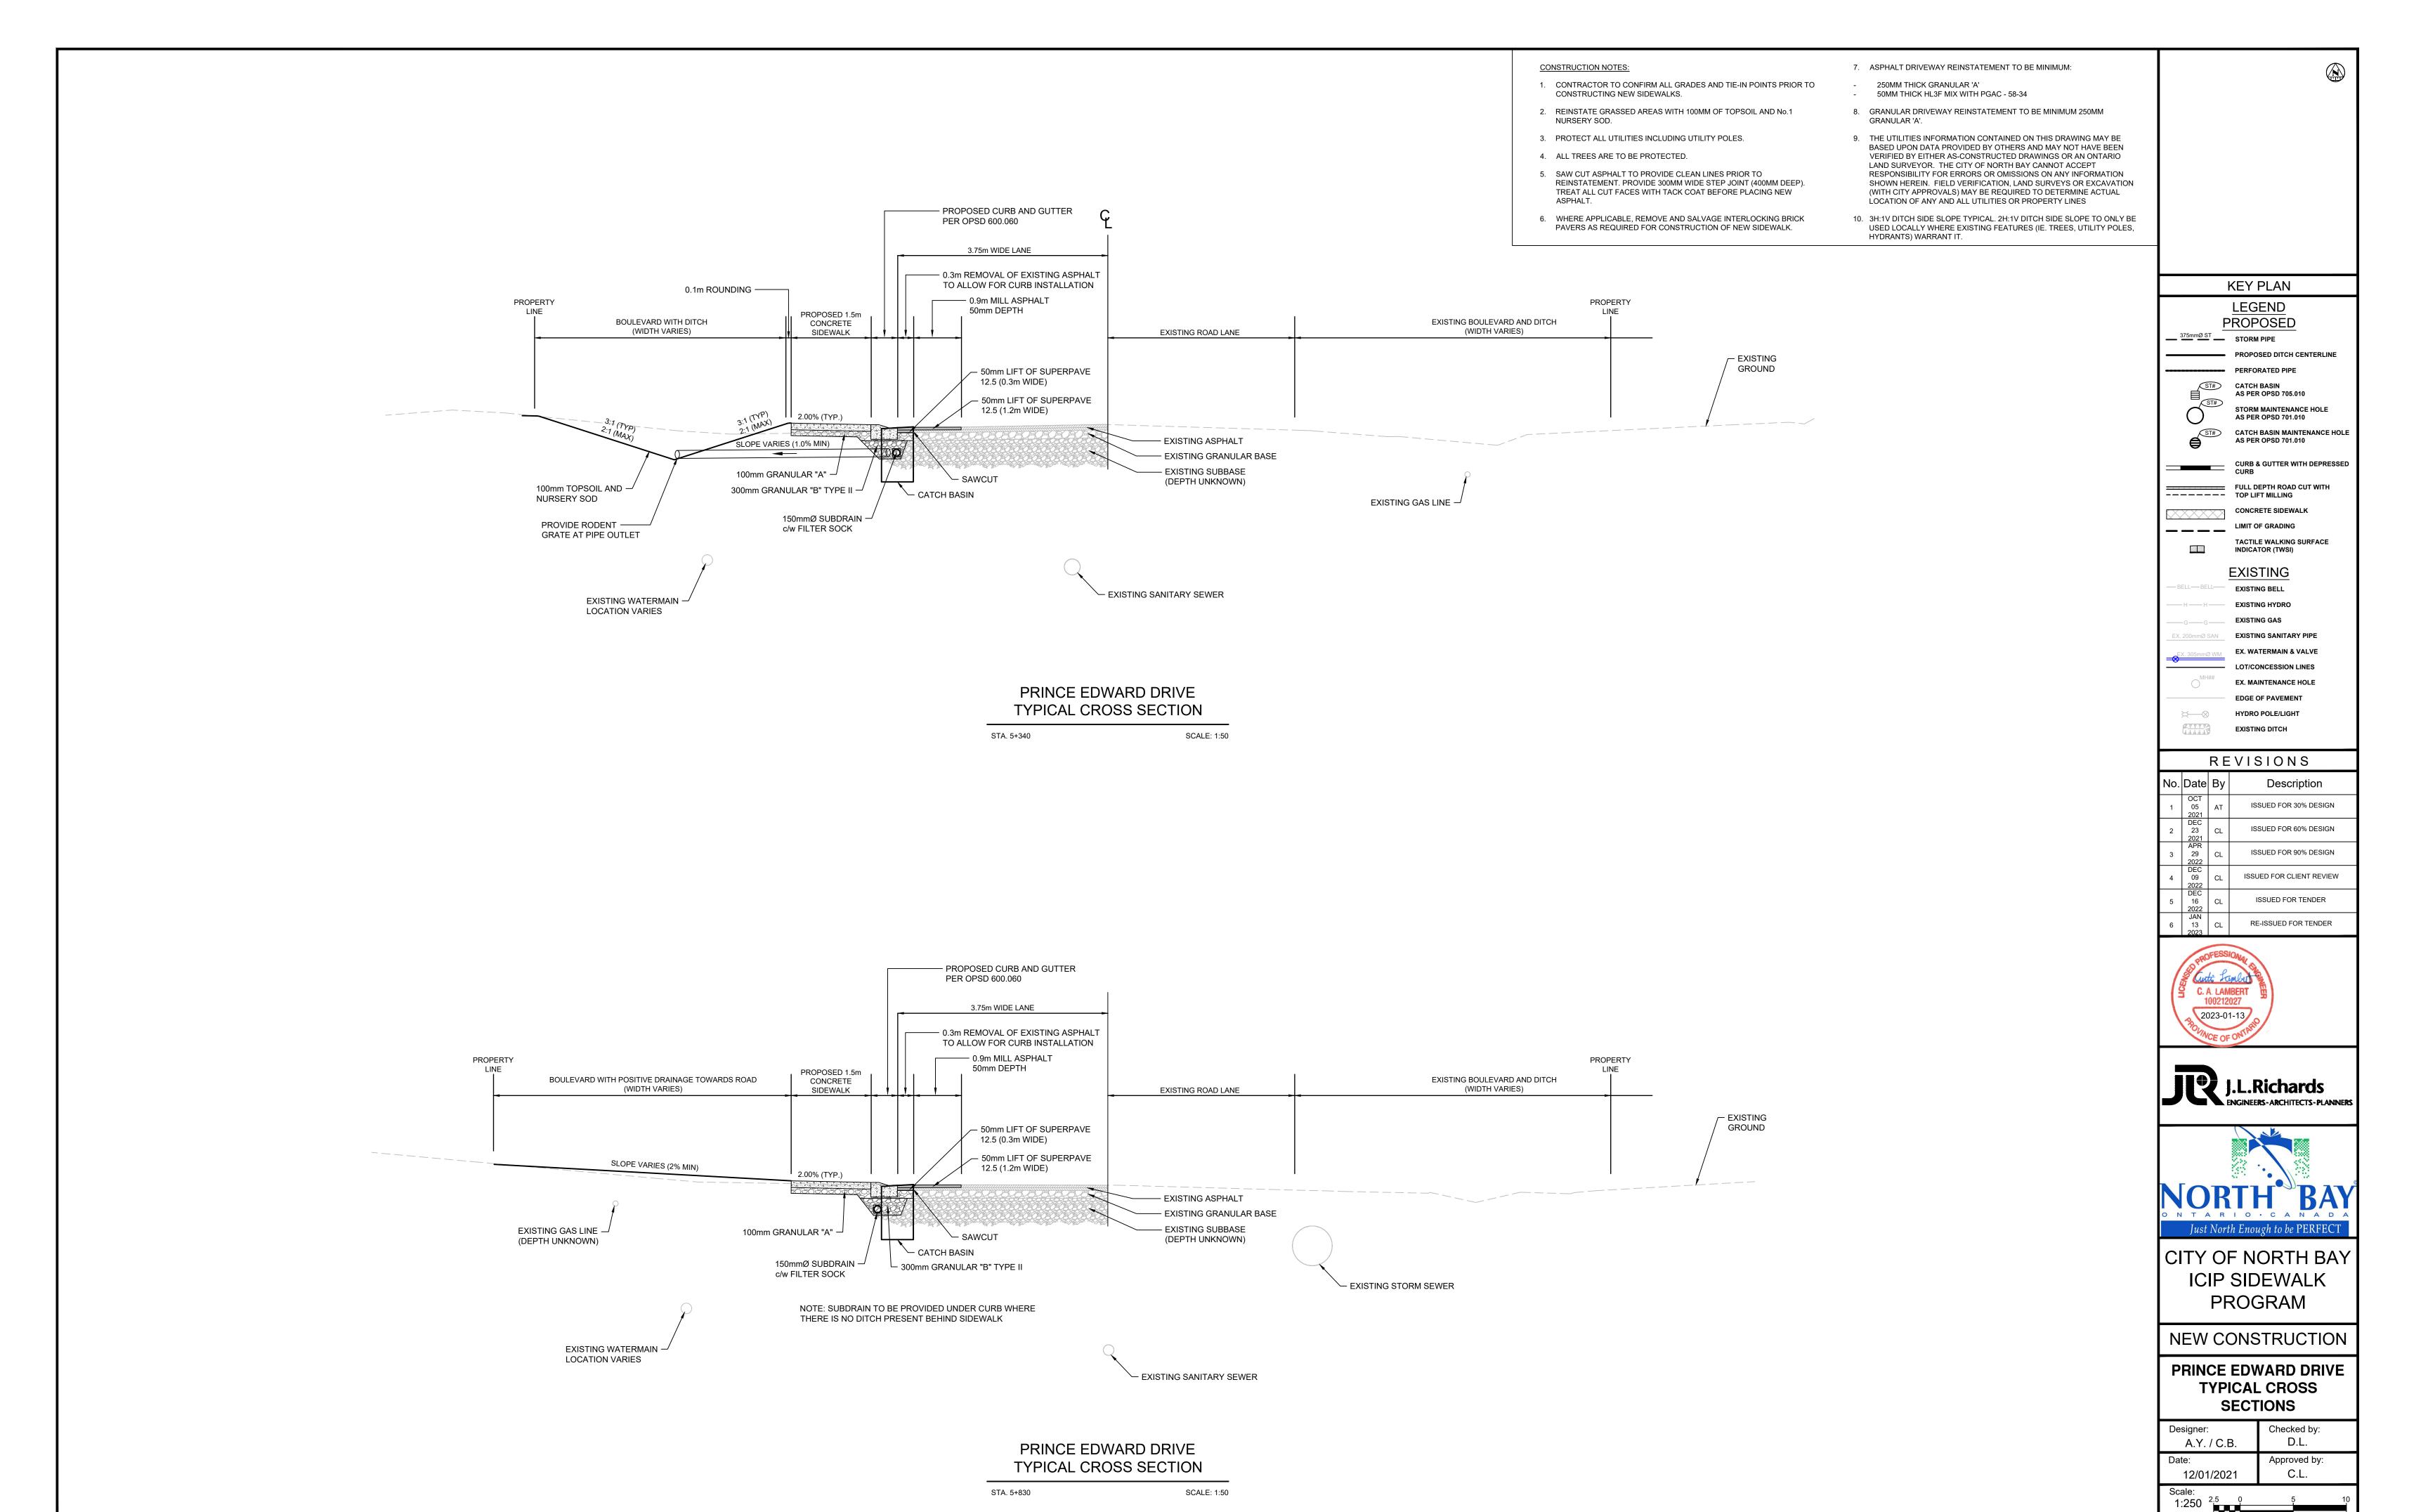

SCALE: 1:50


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Drawing Set: 13 of 19

Drawing Number:

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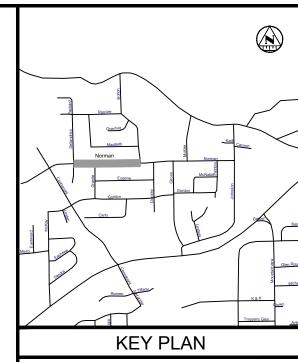


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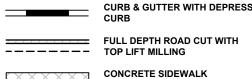
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LEGEND PROPOSED 375mmØST STORM PIPE

ST# CATCH BASIN AS PER OPSD 705.010 STORM MAINTENANCE HOLE AS PER OPSD 701.010 AS PER OPSD 701.010

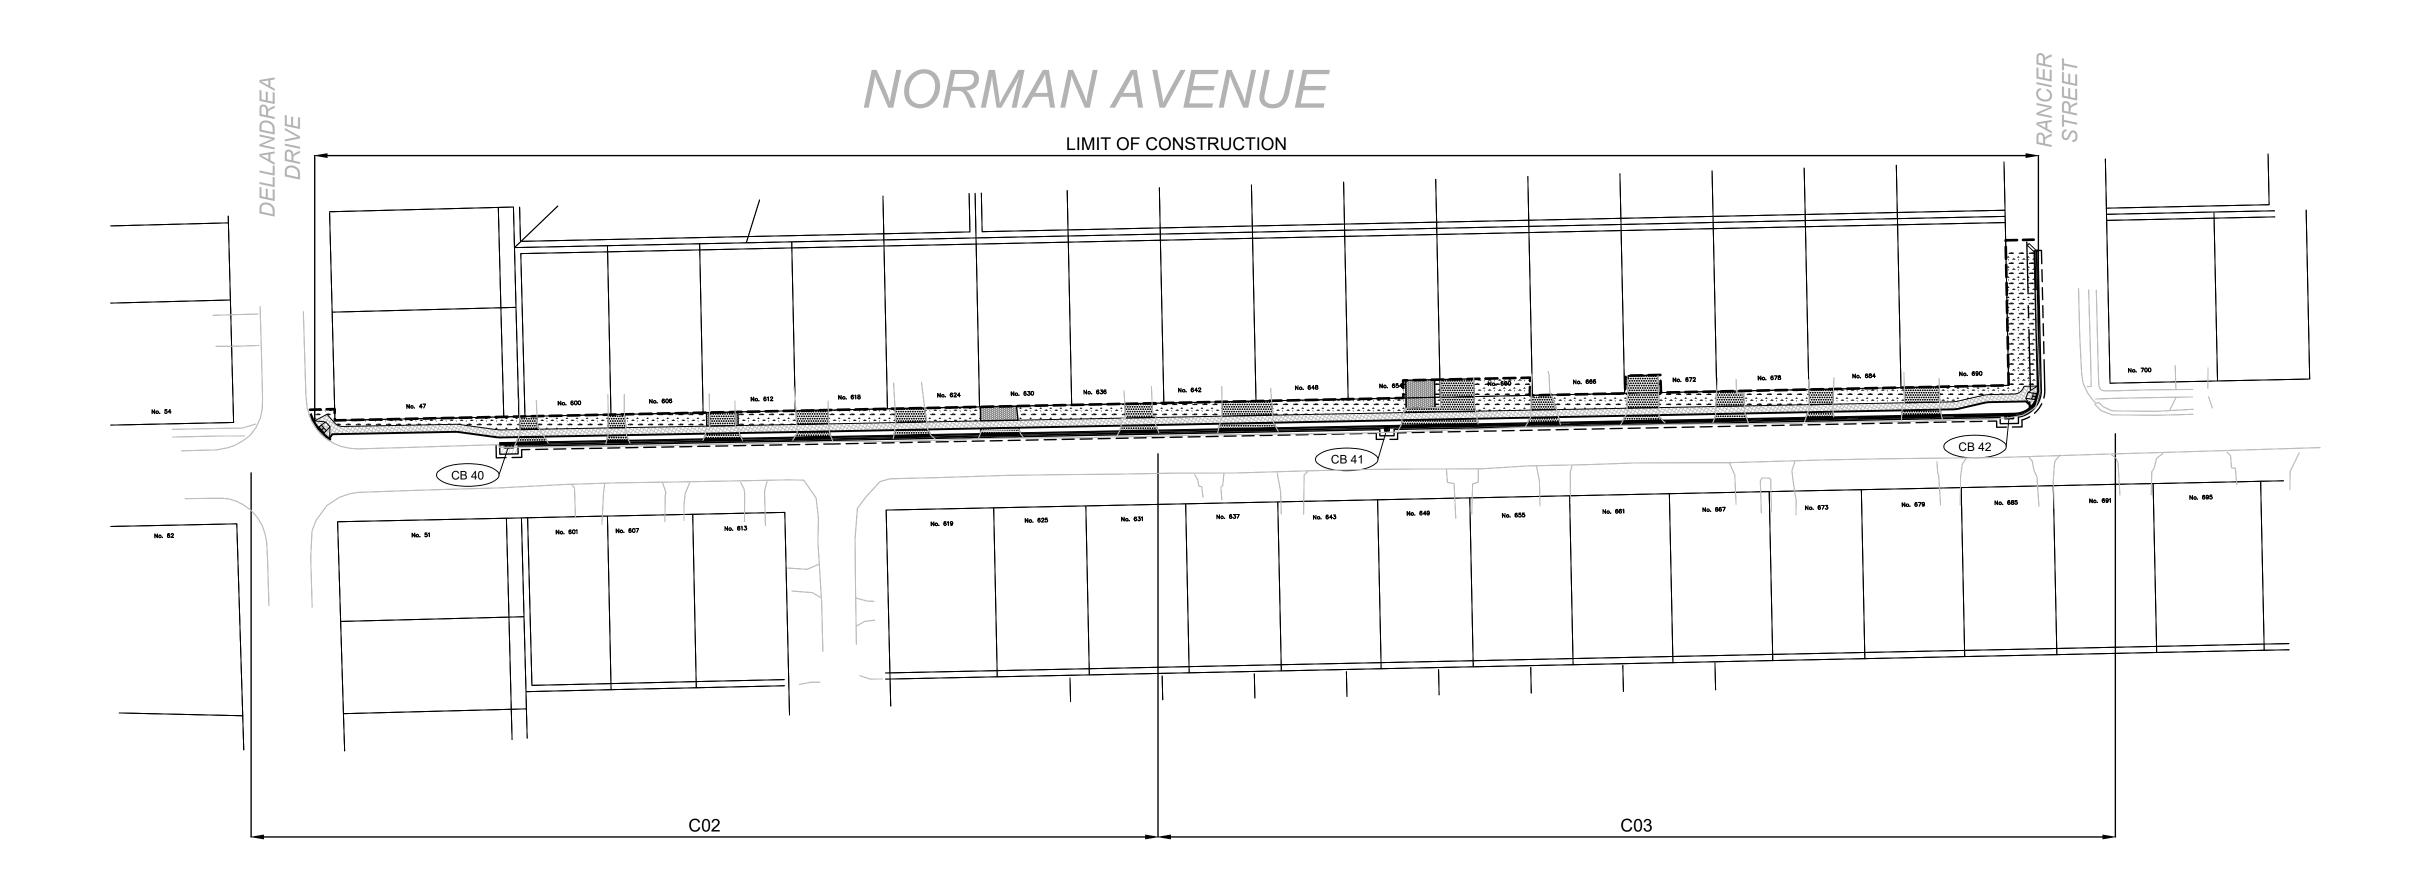

TACTILE WALKING SURFACE INDICATOR (TWSI) **EXISTING**

EXISTING BELL EXISTING HYDRO **EXISTING GAS EXISTING SANITARY PIPE**

LOT/CONCESSION LINES EX. MAINTENANCE HOLE EDGE OF PAVEMENT HYDRO POLE/LIGHT

EXISTING DITCH REVISIONS

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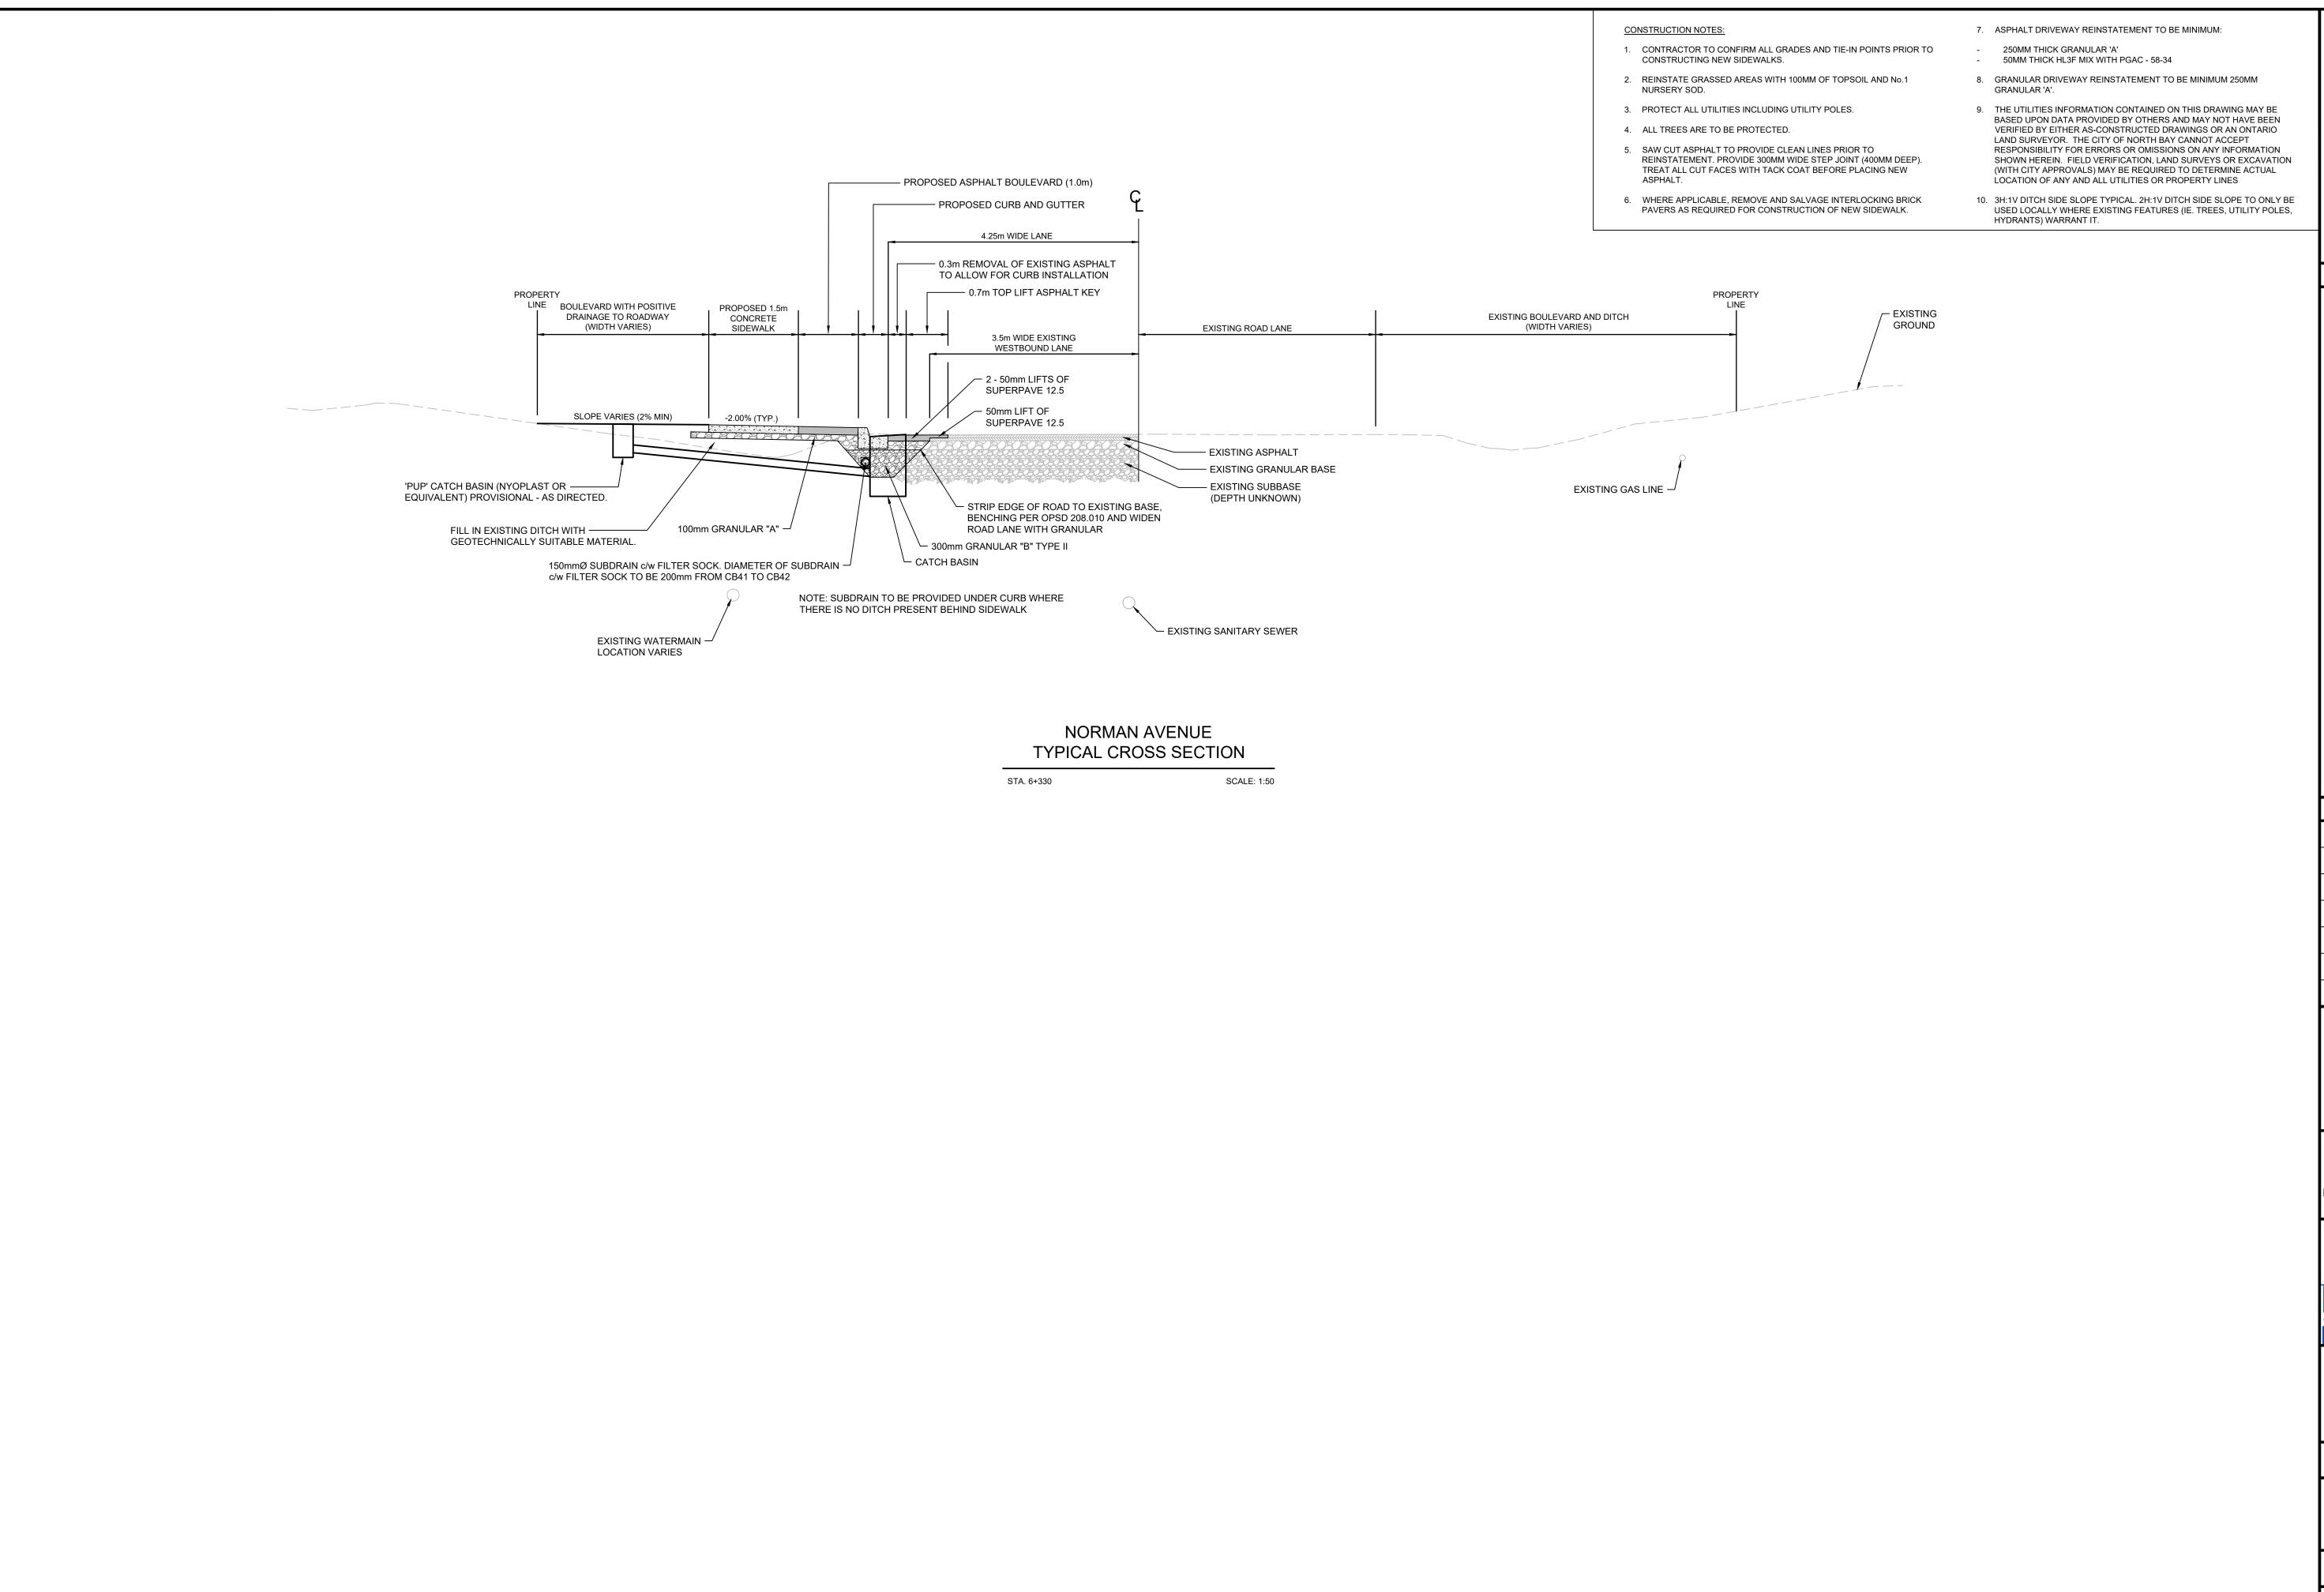
CITY OF NORTH BAY ICIP SIDEWALK PROGRAM

NEW CONSTRUCTION

Norman Avenue General Plan

Designer: A.Y. / C.B.	Checked by: D.L.
Date:	Approved by:
12/01/2021	C.L.
Scale:	

Drawing Set: 15 of 19



KEY PLAN LEGEND PROPOSED ____ 375mmØ ST ____ STORM PIPE PROPOSED DITCH CENTERLINE PERFORATED PIPE ST# CATCH BASIN AS PER OPSD 705.010 STORM MAINTENANCE HOLE AS PER OPSD 701.010 ST# CATCH BASIN MAINTENANCE HOLE AS PER OPSD 701.010 CURB & GUTTER WITH DEPRESSED CURB FULL DEPTH ROAD CUT WITH CONCRETE SIDEWALK TACTILE WALKING SURFACE INDICATOR (TWSI) **EXISTING** EXISTING BELL **EXISTING HYDRO EXISTING GAS** EX. 200mmØ SAN EXISTING SANITARY PIPE EX. WATERMAIN & VALVE LOT/CONCESSION LINES EX. MAINTENANCE HOLE **EDGE OF PAVEMENT** HYDRO POLE/LIGHT

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CITY OF NORTH BAY ICIP SIDEWALK PROGRAM

NEW CONSTRUCTION

NORMAN AVENUE TYPICAL CROSS SECTIONS

Designer: A.Y. / C.B.	Checked by: D.L.
Date: 12/01/2021	Approved by: C.L.
Scale:	

1:250 2.5 0 1:50 0.5 0

Drawing Number: Drawing Set: 18 of 19